Lot 33, DP 1078910 46 FITZROY ST, CARRINGTON

PROPOSED COMMERCIAL DEVELOPMENT

DEVELOPED DESIGN

APRIL 2021

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A004 N Existing Conditions

A006 N Site Analysis

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A200 N Street Elevations

A201 N Elevations

A202 N Elevations

A300 N Sections A301 N Sections

A600 N Materials Schedule


A800 N Shadow Diagrams - 21st July 0900

A801 N Shadow Diagrams - 21st July 1200

A802 N Shadow Diagrams - 21st July 1500



FITZROY ST VIEW - INDICATIVE ONLY

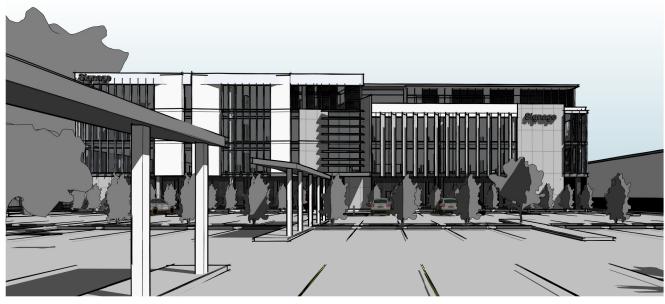

DENISON ST VIEW - INDICATIVE ONLY

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Rev	Description	Date
G	Concept Design	12.11.2020
Н	Issued for Discussion	10.12.2020
1	Issued for Review	15.12.2020
K	Revised for Comment	04.03.2021
L	Issued for Coordination	08.03.2021
M	Floor levels raised	19.03.2021
Ν	Issued for Planning Approval	23.04.2021





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DATE

46 FITZROY ST, CARRINGTON - COMMERCIAL DEVELOPMENT

Cover Sheet STATUS DEVELOPED DESIGN @ A3

DRAWN BY

DRAWING NO.

SCALE PORT OF NEWCASTLE PROJECT NUMBER 2020-116 REVISION N MARCH 2021

Wherever possible, components for this building should be prefabricated off-site or at ground level to minimise the risk of workers falling more than two metres. However, construction of this building will require workers to be working at heights where a fall in excess of two metres is possible and injury is likely to result from such a fall. The builder should provide a suitable barrier wherever a person is required to work in a situation where falling more than two metres is a possibility

a) WORKING AT HEIGHTS

FLOOR FINISHES Specified

If finishes have been specified by designer, these have been selected to minimise the risk of floors and paved areas becoming slippery when wet or when walked on with wet shoes/feet. Any changes to the specified finish should be made in consultation with the designer or, if this is not practical, surfaces with an equivalent or etter slip resistance should be choser

FLOOR FINISHES By Owner

If designer has not not been involved in the selection of surface finishes, the owner is responsible for the selection of surface finishes in the pedestrian trafficable areas of this building. Surfaces should be selected in accordance with AS HB 197:1999 and AS/NZ

STEPS, LOOSE OBJECTS AND UNEVEN SURFACES Due to design restrictions for this building, steps and/or ramps are included in the building which may be a hazard to workers carrying objects or otherwise occupied. Steps should be clearly marked wit both visual and tactile warning during construction, maintenance, demolition and at all times when the building operates as a workplace.

Building owners and occupiers should monitor the pedestrian access ways and in particular access to areas where maintenance is routinely carried out to ensure that surfaces have not moved or cracked so that they become uneven and present a trip hazard. Spills, loose material, stray objects or any other matter that may cause a slip or trip hazard should be cleaned or removed from

Contractors should be required to maintain a tidy work site during construction, maintenance or demolition to reduce the risk of trips and falls in the workplace. Materials for construction or maintenance should be stored in designated areas away from access ways and work areas.

DURING OPERATION OR MAINTENANCE

For houses or other low-rise buildings where scaffolding is appropriate:

Cleaning and maintenance of windows, walls, roof or other components of this building will require persons to be situated where a fall from a height in excess of two metres is possible. Where this type of activity is required, scaffolding, ladders or trestles should be used in accordance with relevant codes of practice,

regulations or legislation.
For buildings where scaffold, ladders, trestles are not appropriate. Cleaning and maintenance of windows, walls, roof or other components of this building will require persons to be situated where a fall from a height in excess of two metres is possible. Where this type of activity is required, scaffolding, fall barriers or Personal Protective Equipment (PPE) should be used in accordance with relevant codes of practice, regulations or legislation. ANCHORAGE POINTS

Anchorage points for portable scaffold or fall arrest devices have been included in the design for use by maintenance workers. Any persons engaged to work on the building after completion of construction work should be informed about the anchorage points. b) SLIPPERY OR UNEVEN SURFACES

Construction, maintenance or demolition work on or around this building is likely to involve persons working above ground level or above floor levels. Where this occurs one or more of the following measures should be taken to avoid objects falling from the area where the work is being carried out onto persons below

- 1. Prevent or restrict access to areas below where the work is being carried out.
 2. Provide toeboards to scaffolding or work platforms.
- Provide protective structure below the work area.
- 4. Ensure that all persons below the work area have Personal Protective Equipment (PPE).
- LOOSE MATERIALS OR SMALL OBJECTS

2. FALLING OBJECTS

During construction, renovation or demolition of this building, parts of the structure including fabricated steelwork, heavy panels and many other components will remain standing prior to or after supporting parts are in place. Contractors should ensure that temporary bracing or other required support is in place at all times when collapse which may injure persons in the area is a possibility.

Mechanical lifting of materials and components during construction maintenance or demolition presents a risk of falling objects. Contractors should ensure that appropriate lifting devices are used, that loads are properly secured and that access to areas below the load is prevented or restricted.

BUILDING COMPONENTS 3 TRAFFIC MANAGEMENT

For building on a major road, narrow road or steeply sloping road: Parking of vehicles or loading/unloading of vehicles on this roadway may cause a traffic hazard. During construction, maintenance or demolition of this building designated parking for workers and loading areas should be provided. Trained traffic management personnel should be responsible for the supervision of these areas. For building where on-site loading/unloading is restricted: Construction of this building will require loading and unloading of materials on the roadway. Deliveries should be well planned to avoid

congestion of loading areas and trained traffic managemen personnel should be used to supervise loading/unloading areas For all buildings:
Busy construction and demolition sites present a risk of collision where

deliveries and other traffic are moving within the site. A traffic management plan supervised by trained traffic management personnel should be adopted for the work site. 4. SERVICES

GENERAL

Rupture of services during excavation or other activity creates a variety of risks including release of hazardous material. Existing services are located on or around this site. Where known, these are identified on the plans but the exact location and extent of services may vary from that indicated. Services should be located using an appropriate service (such as Dial Before You Dig) appropriate excavation practice should be used and, where necessary, specialist contractors should be used.

Locations with underground power: Underground power lines MAY be located in or around this site. All underground power lines must be disconnected or carefully located and adequate warning signs used prior to any construction, maintenance or demolition commencing

Locations with overhead power lines:

Overhead power lines MAY be near or on this site. These pose a risk of electrocution if struck or approached by lifting devices or other plant and persons working above ground level. Where there is a danger of this occurring, power lines should be, where practical onnected or relocated. Where this is not practical adequate warning in the form of bright coloured tape or signage should be used or a protective barrier provided

5. MANUAL TASKS Components within this design with a mass in excess of 25kg should be lifted by two or more workers or by mechanical lifting device. Where this is not practical, suppliers or fabricators should

be required to limit the component mass.

All material packaging, building and maintenance components should clearly show the total mass of packages and where practical all items should be stored on site in a way which minimises bending before lifting. Advice should be provided on safe lifting methods in all areas where lifting may occur. Construction, maintenance and demolition of this building will require the use of portable tools and equipment. These should be fully maintained in accordance with manufacturer's specifications and not used where faulty or (in the case of electrical equipment) not carrying a current electrical safety tag. All safety guards or devices should be regularly checked and Personal Protective Equipment should be used in accordance

with manufacturer's specification.

6. HAZARDOUS SUBSTANCES

ASBESTOS

For alterations to a building constructed prior to 1990: If this existing building was constructed prior to:

1990 - it therefore may contain asbestos

1986 - it therefore is likely to contain asbestos either in cladding material or in fire retardant insulation material. In either case, the builder should check and, if necessary, take appropriate action before demolishing, cutting, sanding, drilling or otherwise disturbing the existing structure.
POWDERED MATERIALS

Many materials used in the construction of this building can cause harm if inhaled in powdered form. Persons working on or in the building during construction, operational maintenance or demolition should ensure good ventilation and wear Personal Protective Equipment including protection against inhalation while using powdered material or when sanding, drilling, cutting or otherwise disturbing or creating powdered materia

TREATED TIMBER The design of this building may include provision for the inclusion of treated timber within the structure. Dust or fumes from this material can be harmful. Persons working on or in the building during construction, operational maintenance or demolition should ensure good ventilation and wear Personal Protective Equipment including protection against inhalation of harmful material when sanding, drilling, cutting or using treated timber in any way that may cause harmful material to be released. Do not burn treated timber VOLATILE ORGANIC COMPOUNDS

Many types of glue, solvents, spray packs, paints, varnishes and some cleaning materials and disinfectants have dangerous emissions. Areas where these are used should be kept well ventilated while the material is being used and for a period after installation. Personal Protective Equipment may also be required. The manufacturer's recommendations for use must be carefully considered at all times.

SYNTHETIC MINERAL FIBRE

Fibreglass, rockwool, ceramic and other material used for thermal or sound insulation may contain synthetic mineral fibre which may be harmful if inhaled or if it comes in contact with the skin, eyes or other sensitive parts or the body. Personal Protective Equipment including protection against inhalation of harmful material should be used when installing, removing or working near bulk insulation material TIMBER FLOORS

This building may contain timber floors which have an applied finish. Areas where finishes are applied should be kept well ventilated during sanding and application and for a period after installation. Personal Protective Equipment may also be required. The manufacturer's recommendations for use must be carefully considered at all times 7. CONFINED SPACES

Construction of this building and some maintenance on the building will require excavation and installation of items within excavations. Where practical, installation should be carried out using methods which do not require workers to enter the excavation. Where this is not practical, adequate support for the excavated area should be provided to prevent collapse. Warning signs and barriers to prevent accidental or unauthorised access to all excavations should be provided.

For buildings with enclosed spaces where maintenance or other access may be required:

Enclosed spaces within this building may present a risk to persons entering for construction, maintenance or any other purpose. The design documentation calls for warning signs and barriers to unauthorised access. These should be maintained throughout the life of the building. Where workers are required to enter enclosed spaces, air testing equipment and Personal Protective Equipmen should be provided.
ENCLOSED SPACES

For buildings with small spaces where maintenance or other access may be required:

Some small spaces within this building will require access by construction or maintenance workers. The design documentation calls for warning signs and barriers to unauthorised access. These should be maintained throughout the life of the building. Where workers are required to enter small spaces they should be scheduled so that access is for short periods. Manual lifting and other manual activity should be restricted in small spaces.

SMALL SPACES

8. PUBLIC ACCESS

Public access to construction and demolition sites and to areas under maintenance causes risk to workers and public. Warning signs and secure barriers to unauthorised access should be provided. Where electrical installations, excavations, plant or loose materials are present they should be secured when not fully

9. OPERATIONAL USE OF BUILDING

This building has been designed as a residential building. If it, at a later date, it is used or intended to be used as a workplace, the provisions of the Work Health and Safety Act 2011 or subsequent replacement Act should be applied to the new use. RESIDENTIAL BUILDINGS

For non-residential buildings where the end-use has not been

This building has been designed to requirements of the classification identified on the drawings. The specific use of the building is not known at the time of the design and a further assessment of the workplace health and safety issues should be undertaken at the time of fit-out for the end-user.

NON-RESIDENTIAL BUILDINGS

For non-residential buildings where the end-use is known: This building has been designed for the specific use as identified on the drawings. Where a change of use occurs at a later date a further assessment of the workplace health and safety issues should be undertaken

10.OTHER HIGH RISK ACTIVITY

All electrical work should be carried out in accordance with Code of Practice: Managing Electrical Risks at the Workplace, AS/NZ 3012 and all licensing requirements.

All work using Plant should be carried out in accordance with Code of Practice: Managing Risks of Plant at the Workplace. All work should be carried out in accordance with Code of Practice: Managing Noise and Preventing Hearing Loss at Work. Due to the history of serious incidents it is recommended that particular care be exercised when undertaking work involving steel construction and concrete placement. All the above applies.

BCA BUILDING CLASS

= 5 (OFFICE) = 6 (CAFE)

TYPE 'A' CONSTRUCTION REQ'D SINGLE FIRE COMPARTMENT (<8000sqm)

- CAR PARKING = LOWER THAN DCP REQ

- EV CHARGING/PARKING = 5% OR PARKING
- BICYCLE PARKING = 7.5% OF BUILDING POP - 75% OF SITE LANDSCAPED OR LIGHT ROOFING

- VIEWS AND NATURAL LIGHT IN OFFICE AREAS

GROUND

OFFICE BUILDING - GROUND LEVEL AREA GFA POPULATION = 838.2sqm

FEMALE TOILETS

LEVEL2

= 84 (10sgm PP) MALE TOILETS = 4 PANS (1:20 @ 100MALES)

= 3 URINALS (1:25 UP TO 50) THEN +1PER 50)

= 5 PANS (1:15 @ 100FEMALES)

= 1 UNISEX (COUNTS FOR 1 MALE & 1 FEMALE PAN) DISABLED WC

TOTAL TOILETS = 3 MALE PANS + 3 URINALS

= 4 FEMALE PANS = 1 UNISEX DDA TOILET

= 17 SPACES (@1:50sam) CAR PARKING BIKE PARKING = 4 SPACES (@1:200sam)

MOTORBIKE PARKING = 1 SPACES (@1:20cars)

LEVEL3

LEVEL1

MALE TOILETS

FEMALE TOILETS

DISABLED WC

TOTAL TOILETS

CAR PARKING

BIKE PARKING

OFFICE BUILDING - LEVEL 1

POPULATION = 193 (10sqm PP

OFFICE BUILDING - LEVEL 2 POPULATION = 197 (10sqm PP)

MALE TOILETS = 5 PANS (1:20 @ 100MALES)

= 3 URINALS (1:25 UP TO 50) THEN +1PER 50)

= 7 PANS (1:15 @ 100FFMALES) FEMALE TOILETS DISABLED WC = 1 UNISEX (COUNTS FOR 1 MALE & 1 FEMALE PAN)

= 4 MALE PANS + 4 URINALS **TOTAL TOILETS** - 6 FEMALE PANS

= 1 UNISEX DDA TOILET CAR PARKING = 40 SPACES (@1:50sam)

BIKE PARKING = 10 SPACES (@1:200sqm) MOTORBIKE PARKING = 2 SPACES (@1:20cars)

OFFICE BUILDING - LEVEL 3 POPULATION = 170 (10sam PP

MALE TOILETS

MOTORRIKE PARKING = 2 SPACES (@1:20cars)

= 4 PANS (1:20 @ 100MALES)

= 3 URINALS (1:25 UP TO 50) THEN +1PER 50) FEMALE TOILETS = 6 PANS (1:15 @ 100FEMALES)

= 5 PANS (1:20 @ 100MALES)

= 7 PANS (1:15 @ 100FEMALES)

= 4 MALE PANS + 4 URINALS

= 6 FEMALE PANS

= 1 UNISEX DDA TOILET

= 39 SPACES (@1:50sqm)

= 10 SPACES (@1:200sam)

= 3 URINALS (1:25 UP TO 50) THEN +1PER 50)

= 1 UNISEX (COUNTS FOR 1 MALE & 1 FEMALE PAN

DISABLED WC = 1 UNISEX (COUNTS FOR 1 MALE & 1 FEMALE PAN)

TOTAL TOILETS = 3 MALE PANS + 3 URINALS

= 5 FEMALE PANS = 1 UNISEX DDA TOILET CAR PARKING = 32 SPACES (@1:50sam)

BIKE PARKING = 8 SPACES (@1:200sam)

MOTORBIKE PARKING = 2 SPACES (@1:20cars)

SUMMARY

PARKING OFFICE BUILDING - TOTALS VISITOR = 6432sqm SECURE = 23 = 644

POPULATION SITE AREA = 8685sqm STAFF (ext) = 138 = 172 (43 spaces above requirement) TOTAL = 0.74:1

No. LEVELS M. BIKE

DEEP SOIL LANDSCAPING = 1003sgm (1m min W) PERMEABLE CARPARKING = 2000sgm

- 3 ACCESSIBLE SPACES Includes 1 LOADING BAY - 8 EV CHARGING BAYS

AREA SUMMARY NLA/GLFA GFA LOBBY LIFT/STAIRS TOILETS **TERRACE** PLANT EFFICIENCY GROUND 655sqm 838.2sqm 76sqm 62sqm 108sqm 8.7sqm LEVEL 1 1842sqm 68sqm 60sqm 7sqm 35sqm EVEL 2 1838sqm 1965.4sqm | 6 68sqm 7sqm 60sqm LEVEL 3 1570sqm 1697.5sqm | 6 7sqm 68sqm 60sqm 173sqm 8.7sqm 92% 3sam sam TOTALS 5905sqm 6432sqm 282sqm 289sqm 288sgm 243sgm 143.8sgm 92%

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Rev Description Date Site Options 07.02.2020 Issued for Planning Approval 23.04.2021





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46 FITZROY ST, CARRINGTON - COMMERCIAL DEVELOPMENT


Notes & Schedules DEVELOPED DESIGN @ A3 STATUS

DRAWN BY

SCALE PORT OF NEWCASTLE

PROJECT NUMBER REVISION N 2020-116 DRAWING NO. DATE MARCH 2021

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Rev	Description	Date
F	Proposed Site Concept	26.10.2020
G	Concept Design	12.11.2020
1	Issued for Review	15.12.2020
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CONCEPT DESIGN

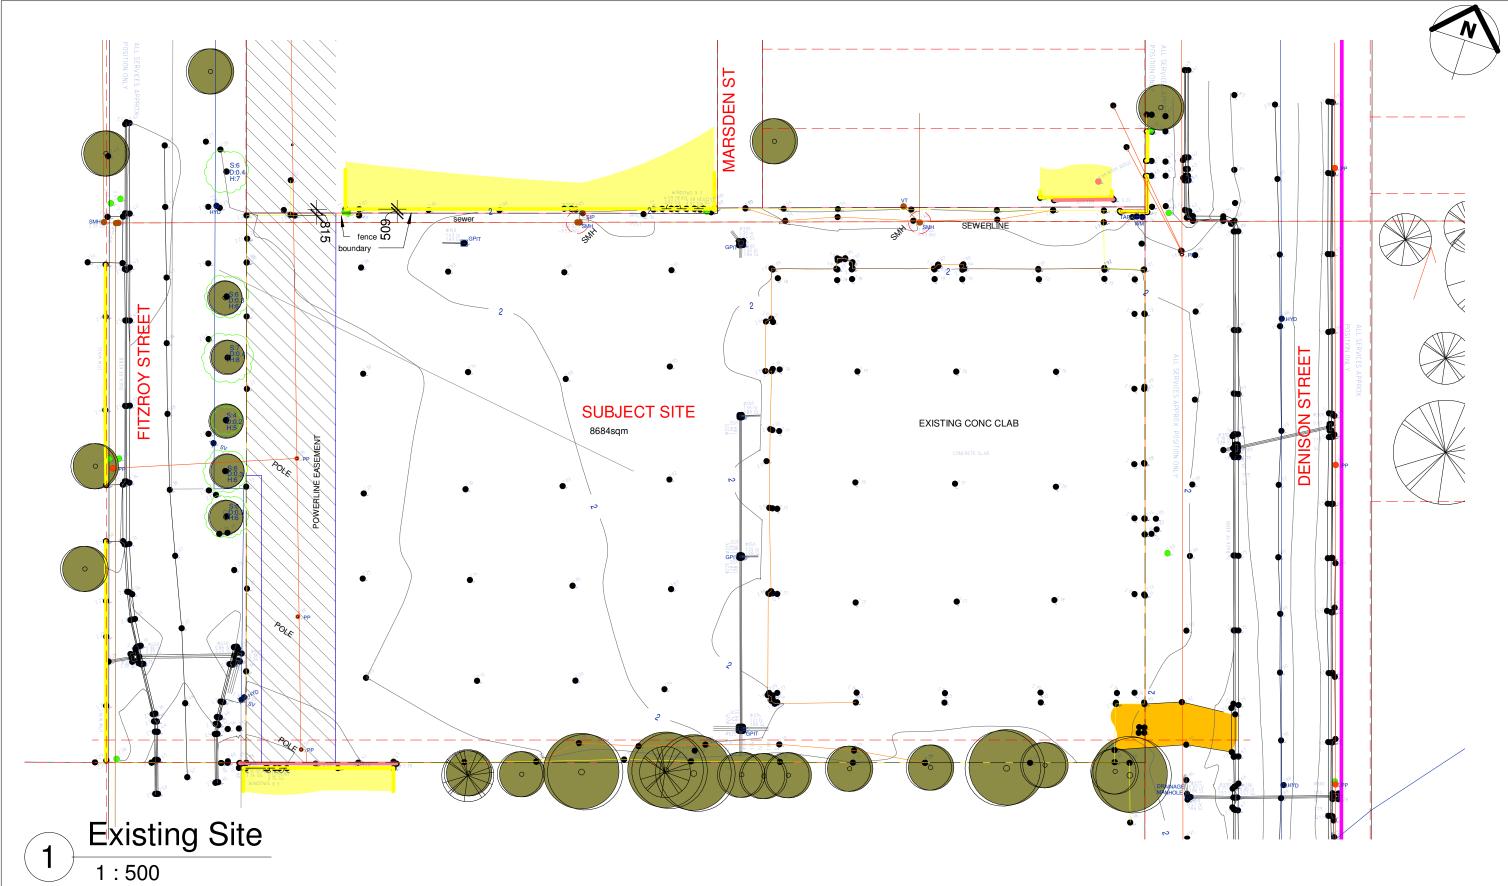46 FITZROY ST, CARRINGTON - COMMERCIAL DEVELOPMENT

Existing Conditions

PORT OF NEWCASTLE

STATUS DEVELO

TATUS DEVELOPED DESIGN @ A3

DRAWN BY SCALE

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PROJECT NUMBER 2020-116 REVISION N
DATE MARCH 2021 DRAWING NO.

A004



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A	Site Options	07.02.2020
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CONCEPT DESIGN

46 FITZROY ST, CARRINGTON - COMMERCIAL DEVELOPMENT

Site Analysis STATUS DEVELOPED DESIGN @ A3

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SCALE 1:2500

PORT OF NEWCASTLE SCALE

PROJECT NUMBER 2020-116 REVISION N

DATE MARCH 2021 DRAWING NO.

A006



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CONCEPT DESIGN

46 FITZROY ST, CARRINGTON - COMMERCIAL DEVELOPMENT

Site Context Plan


PORT OF NEWCASTLE

DEVELOPED DESIGN @ A3 STATUS

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SCALE 1:750

PROJECT NUMBER 2020-116 REVISION N DRAWING NO. DATE MARCH 2021

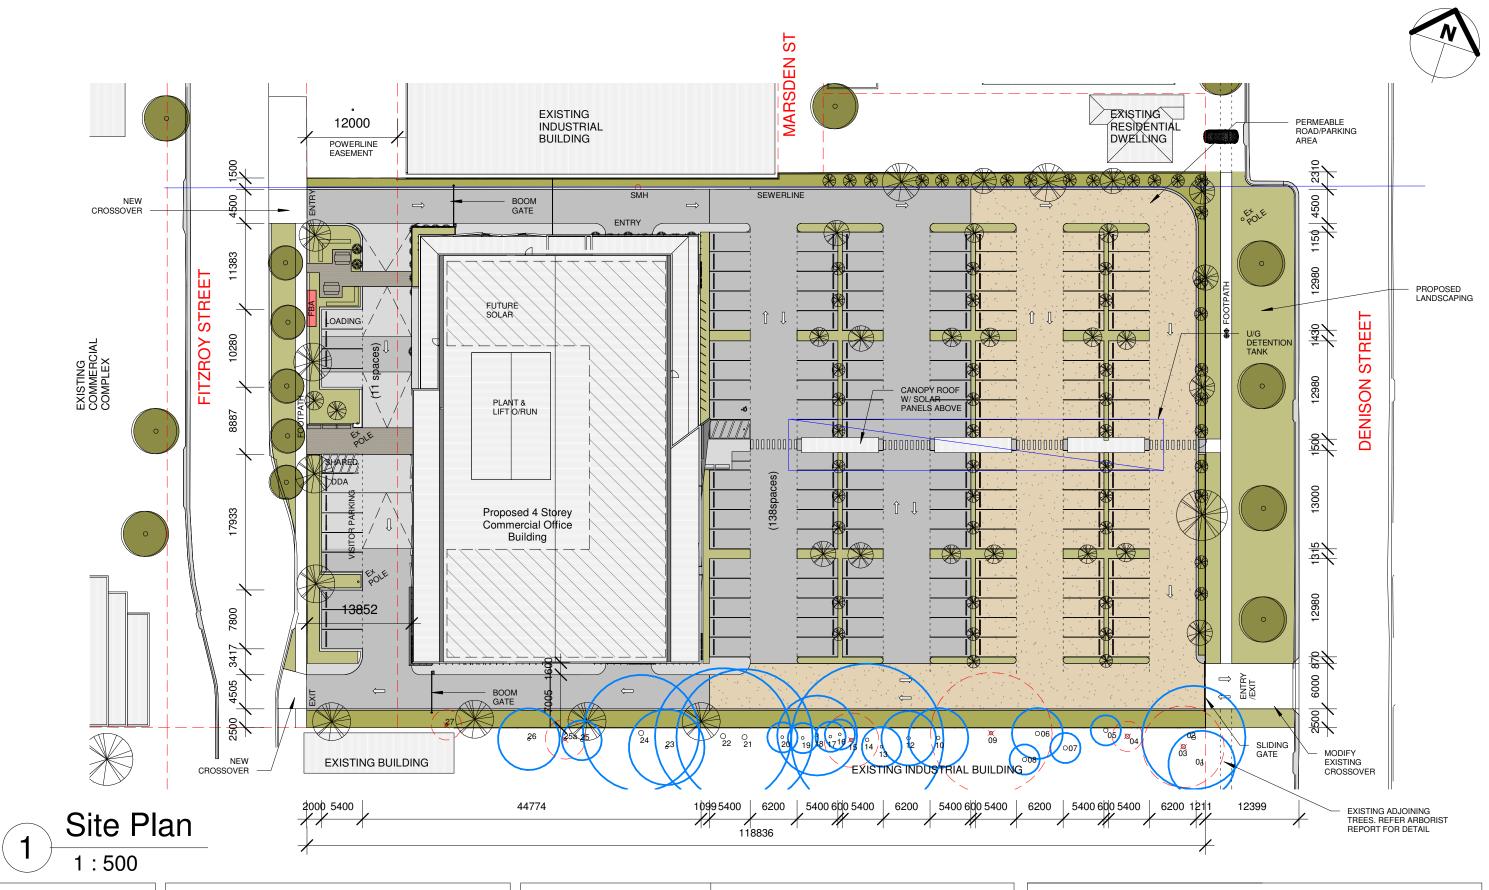

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CONCEPT DESIGN

46 FITZROY ST, CARRINGTON - COMMERCIAL DEVELOPMENT

 Site Plan
 STATUS
 DEVELOPED DESIGN @ A3

 DRAWN BY
 BR

 PORT OF NEWCASTLE
 SCALE
 1 : 500

PROJECT NUMBER 2020-116 REVISION N
DATE MARCH 2021 DRAWING NO.

REVISION N DRAWING NO. A100





1:500

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.,	issued for Flamming Approval	20.04.2021



CONCEPT DESIGN

46 FITZROY ST, CARRINGTON - COMMERCIAL DEVELOPMENT

Site Ground Plan STATUS DEVELOPED DESIGN @ A3

DRAWN BY SCALE PORT OF NEWCASTLE

PROJECT NUMBER 2020-116 REVISION N DATE MARCH 2021 DRAWING NO.

1:500







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CLIENT



TEAM





Rev	Description	Date
С	Draft Concept Plans	18.02.2020
D	Concept Plans for Review	20.02.2020
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G	Concept Design	12.11.2020
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CONCEPT DESIGN

46 FITZROY ST, CARRINGTON -COMMERCIAL DEVELOPMENT

PORT OF NEWCASTLE

First Floor Plan

PROJECT NUMBER 2020-116 DATE MARCH 2021

STATUS DEVELOPED DESIGN @ A3

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BR

1:250

DRAWING NO.

SCALE

REVISION





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46 FITZROY ST, CARRINGTON -COMMERCIAL DEVELOPMENT

PORT OF NEWCASTLE

Second Floor Plan

2020-116 MARCH 2021

DEVELOPED DESIGN @ A3

BR

1:250



OFFICE BUILDING - LEVEL 3 POPULATION = 170 (10sqm PP)

= 3 MALE PANS + 3 URINALS = 5 FEMALE PANS = 1 UNISEX DDA TOILET

= 32 SPACES (@1:50sqm)

= 8 SPACES (@1:200sqm)

MOTORBIKE PARKING = 2 SPACES (@1:20cars)

MALE TOILETS


FEMALE TOILETS

DISABLED WC

TOTAL TOILETS

CAR PARKING

BIKE PARKING

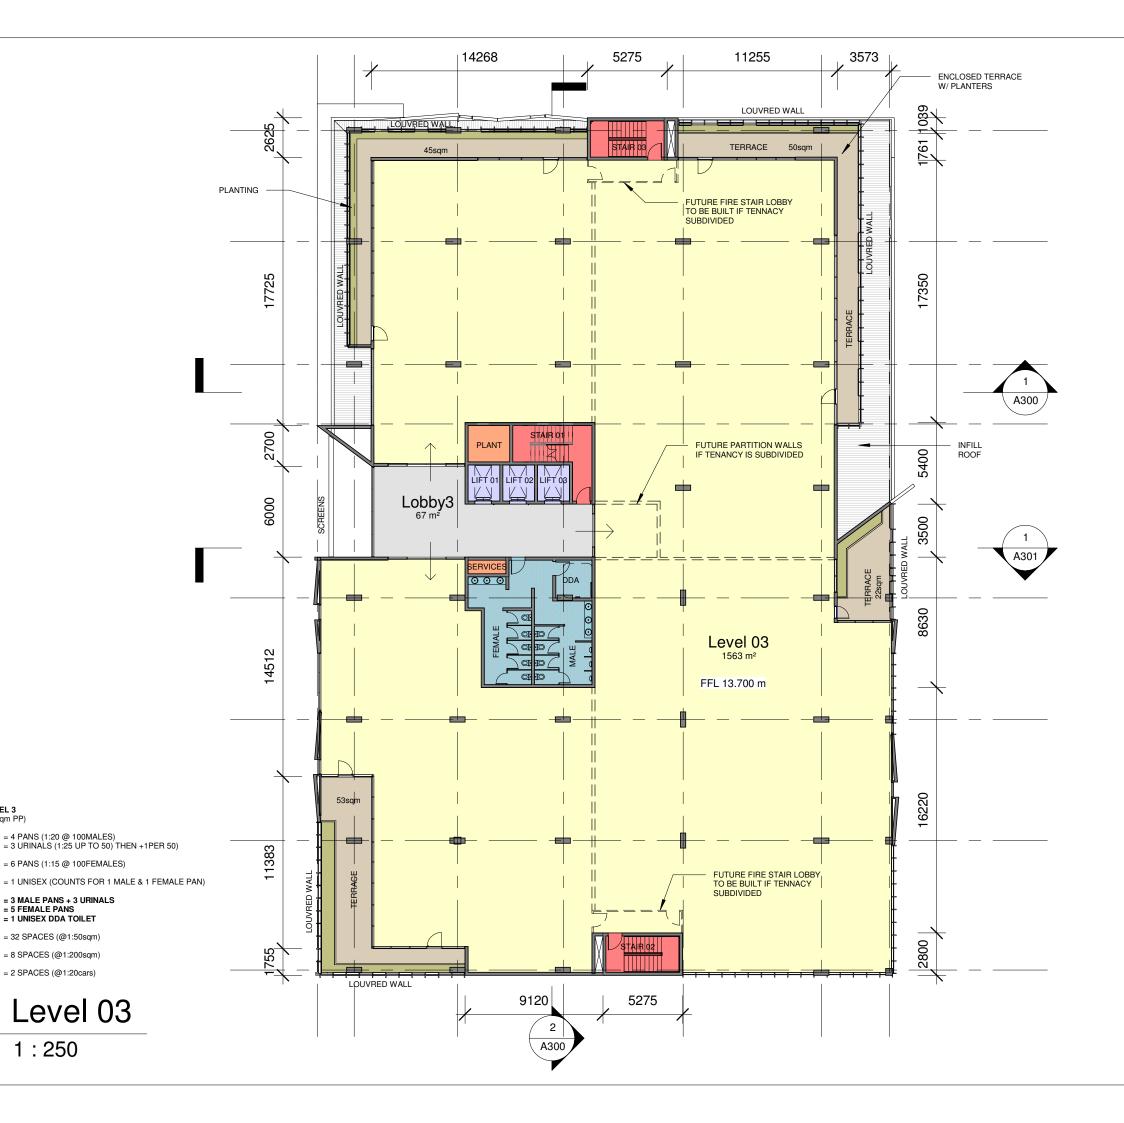



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PORT OF NEWCASTLE

Third Floor Plan

PROJECT NUMBER 2020-116

DATE MARCH 2021

STATUS DEVELOPED DESIGN @ A3


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SCALE 1:250

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Fitzroy St

1:350



2

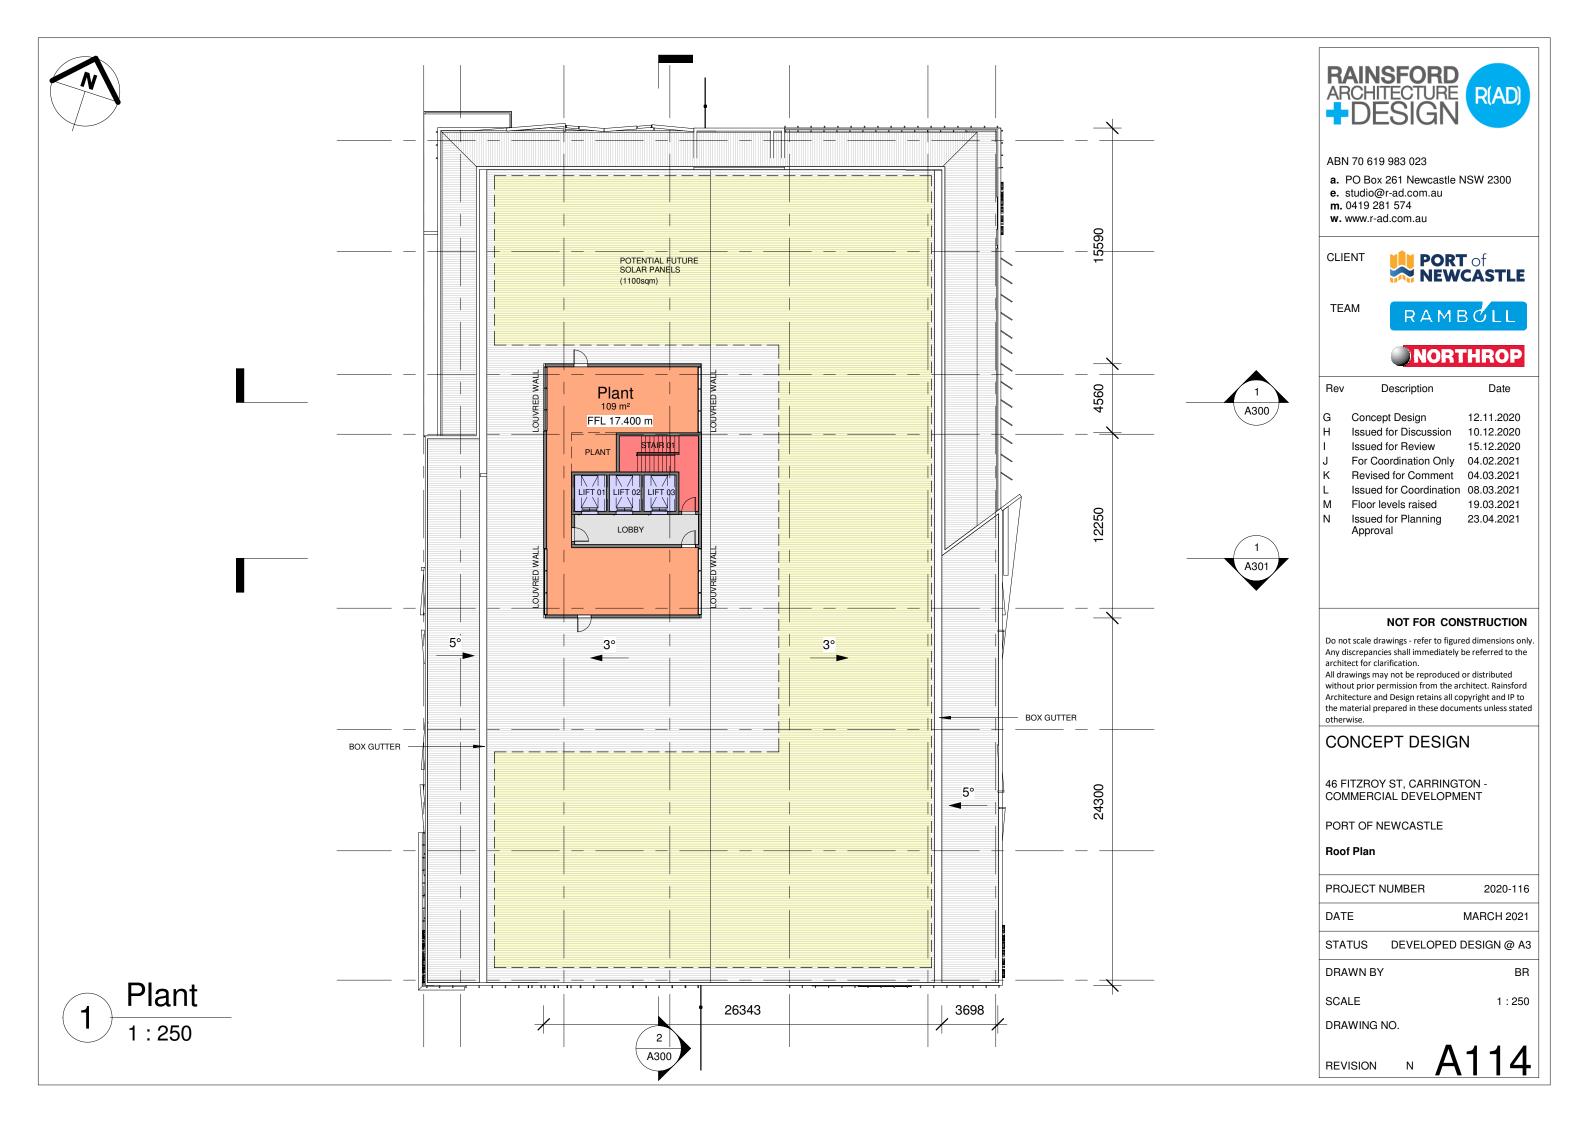Denison St

1:350

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CONCEPT DESIGN

46 FITZROY ST, CARRINGTON - COMMERCIAL DEVELOPMENT

Street Elevations STATUS DEVEL


STATUS DEVELOPED DESIGN @ A3
DRAWN BY BR

PORT OF NEWCASTLE SCALE

PROJECT NUMBER 2020-116 REVISION N
DATE MARCH 2021 DRAWING NO.

A200

1:350

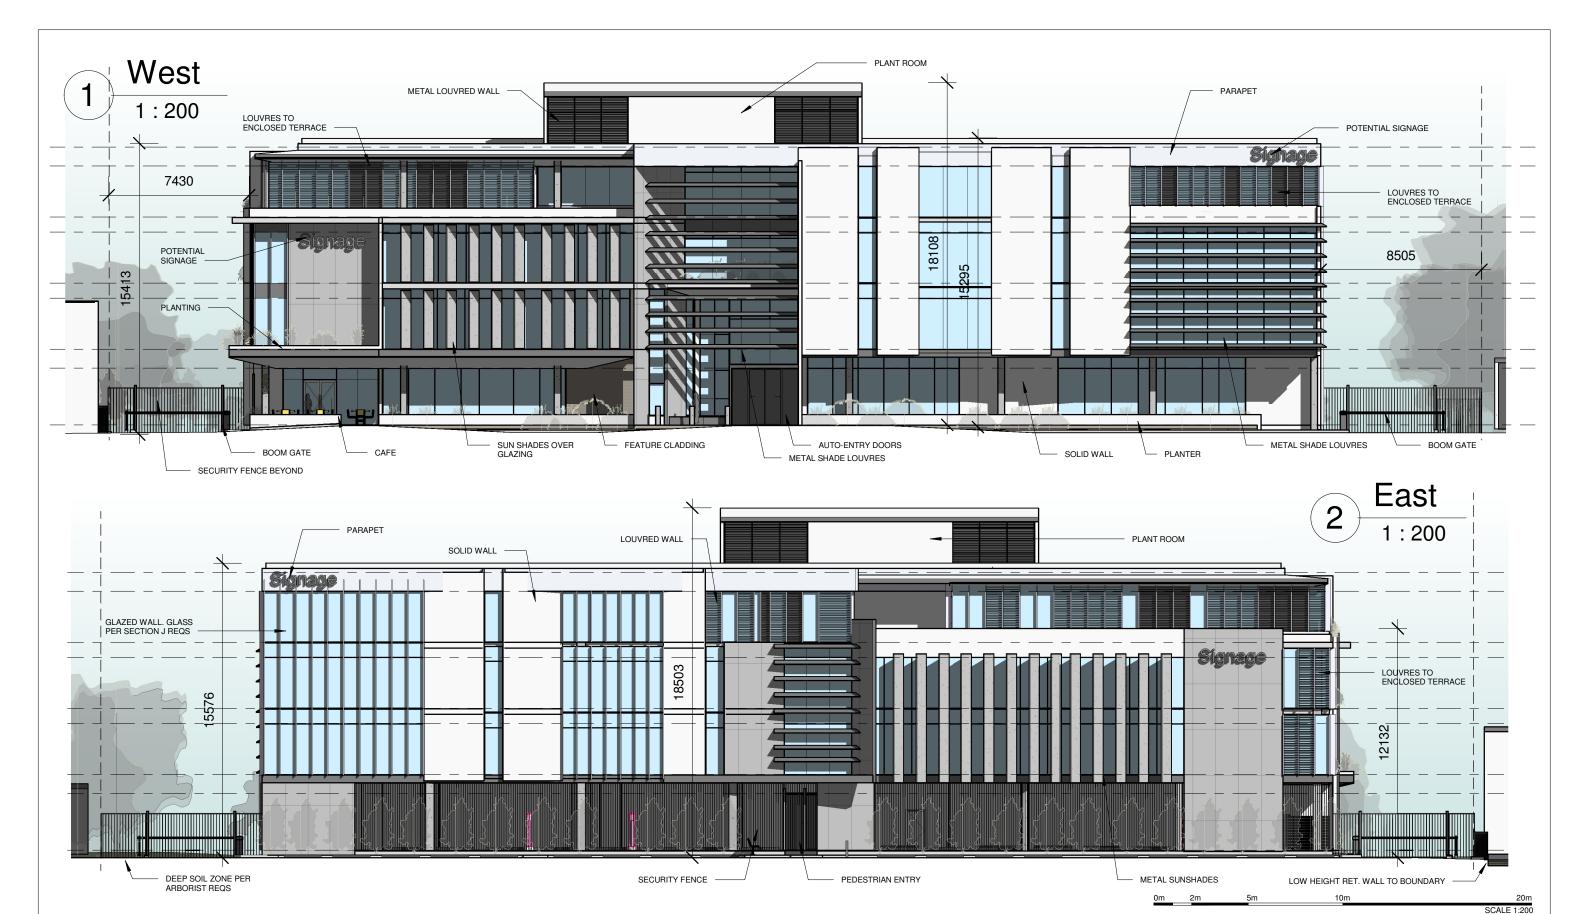

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Rev	Description	Date
A G K L	Site Options Concept Design Revised for Comment Issued for Coordination Floor levels raised	07.02.2020 12.11.2020 04.03.2021 08.03.2021 19.03.2021
N	Issued for Planning Approval	23.04.2021











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CONCEPT DESIGN

46 FITZROY ST, CARRINGTON - COMMERCIAL DEVELOPMENT

Elevations

STATUS

DEVELOPED DESIGN @ A3

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BR

PORT OF NEWCASTLE

SCALE

1:200

PROJECT NUMBER 2020-116 REVISION N
DATE MARCH 2021 DRAWING NO.

A20⁻



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Rev	Description	Date
G	Concept Design	12.11.2020
K	Revised for Comment	04.03.2021
L	Issued for Coordination	08.03.2021
M	Floor levels raised	19.03.2021
N	Issued for Planning Approval	23.04.2021



NORTHROP



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CONCEPT DESIGN


DATE


46 FITZROY ST, CARRINGTON - COMMERCIAL DEVELOPMENT

MARCH 2021

Elevations STATUS DEVELOPED DESIGN @ A3 DRAWN BY BR SCALE 1:200 PORT OF NEWCASTLE PROJECT NUMBER 2020-116 REVISION N

DRAWING NO.

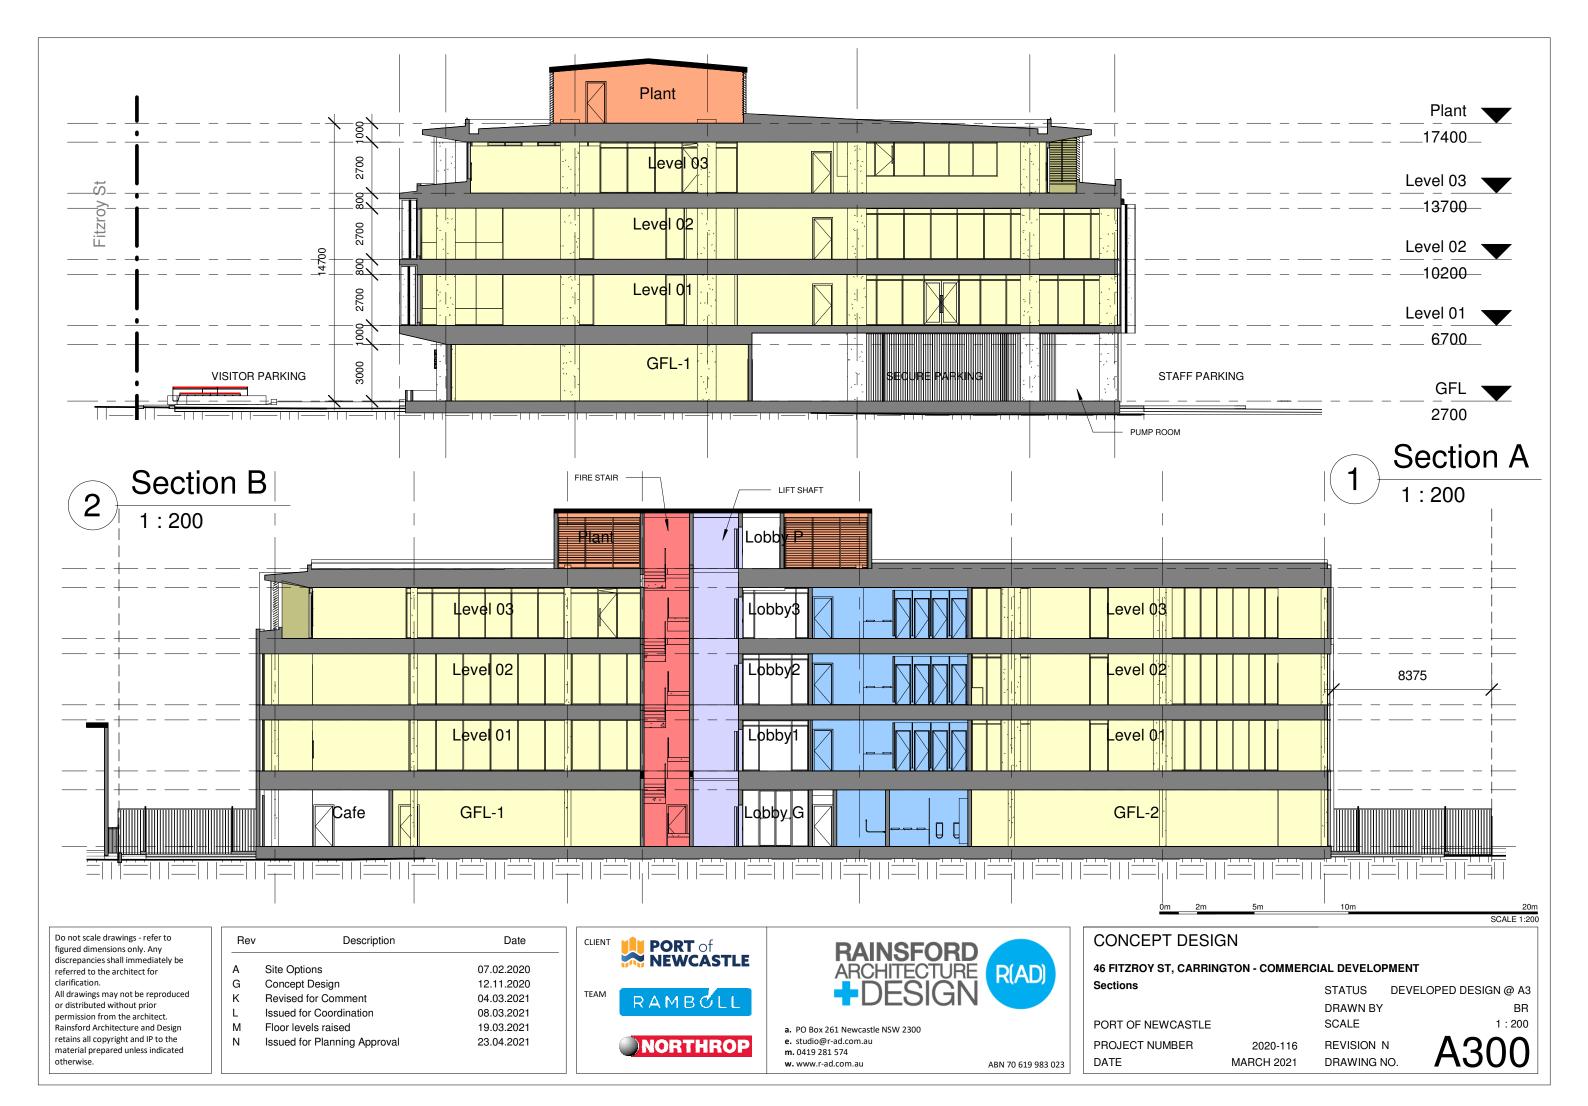

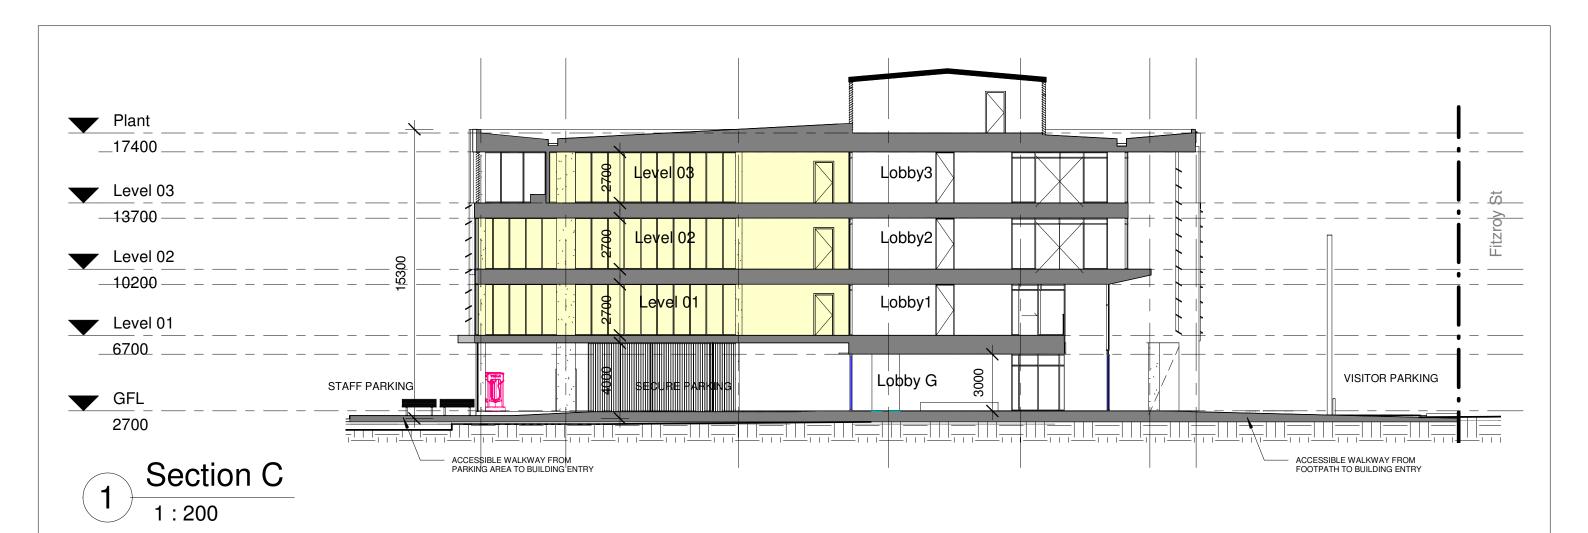

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Rev	Description	Date
G	Concept Design	12.11.2020
K	Revised for Comment	04.03.2021
L	Issued for Coordination	08.03.2021
M	Floor levels raised	19.03.2021
N	Issued for Planning Approval	23.04.2021
	5	







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0m	2m	5m	10m	20n
				SCALE 1:20

CONCEPT DESIGN


46 FITZROY ST, CARRINGTON - COMMERCIAL DEVELOPMENT

Sections DEVELOPED DESIGN @ A3 STATUS

DRAWN BY

BR SCALE 1:200 PORT OF NEWCASTLE PROJECT NUMBER 2020-116 REVISION N DATE MARCH 2021 DRAWING NO.



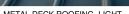



PERFORATED METAL LOUVRE BLADES



CURTAIN WALL GLAZING SYSTEM



PREFINISHED COMPOSITE SHEET CLADDING. WHITE



METAL & GLASS OPERABLE LOUVRES



PREFINSIHED CFC CLADDING PANELS



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PREFINISHED FEATURE SOFFIT LINING



FEATURE MASONRY CONSTRUCTION



OFF-FORM CONCRETE



FIXED METAL LOUVRE BLADES











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CONCEPT DESIGN

46 FITZROY ST, CARRINGTON - COMMERCIAL DEVELOPMENT

Materials Schedule

DATE


PORT OF NEWCASTLE

DEVELOPED DESIGN @ A3 STATUS

DRAWN BY

SCALE


PROJECT NUMBER 2020-116 REVISION N DRAWING NO. MARCH 2021

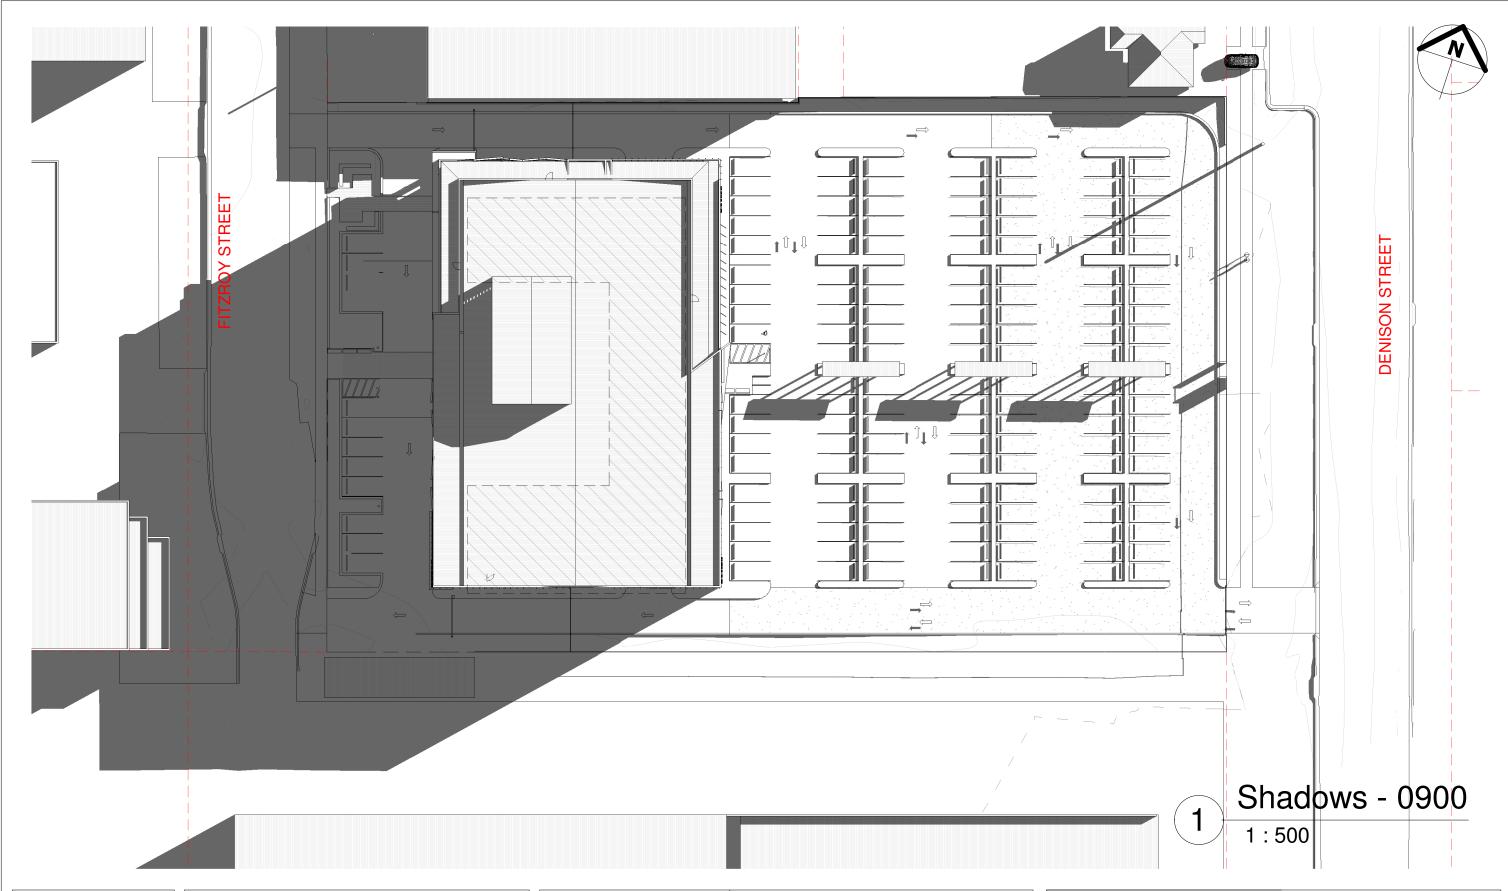

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CONCEPT DESIGN

46 FITZROY ST, CARRINGTON - COMMERCIAL DEVELOPMENT

Shadow Diagrams - 21st June 0900 STATUS DEVELOPED DESIGN @ A3

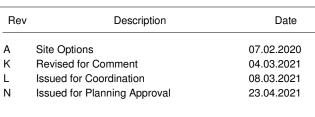
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PORT OF NEWCASTLE SCALE 1 : 500

PROJECT NUMBER 2020-116 REVISION N
DATE MARCH 2021 DRAWING NO.

DRAWN BY
BR
1 : 500

A800

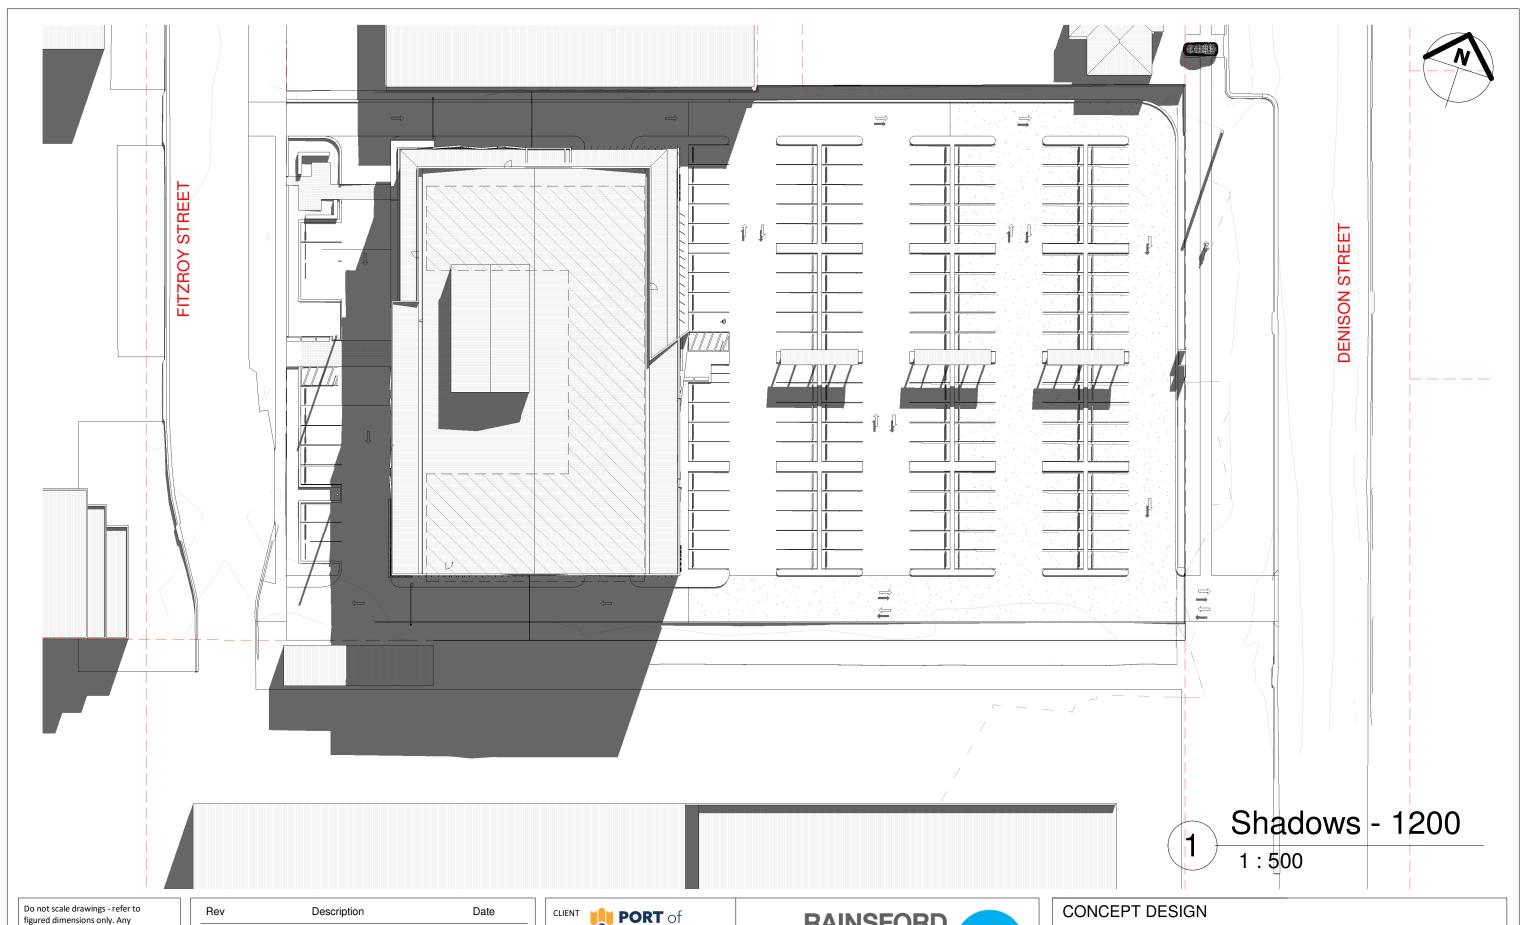

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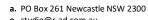
Rev	Description	Date
K L	Revised for Comment	04.03.2021 08.03.2021
N	Issued for Planning Approval	23.04.2021



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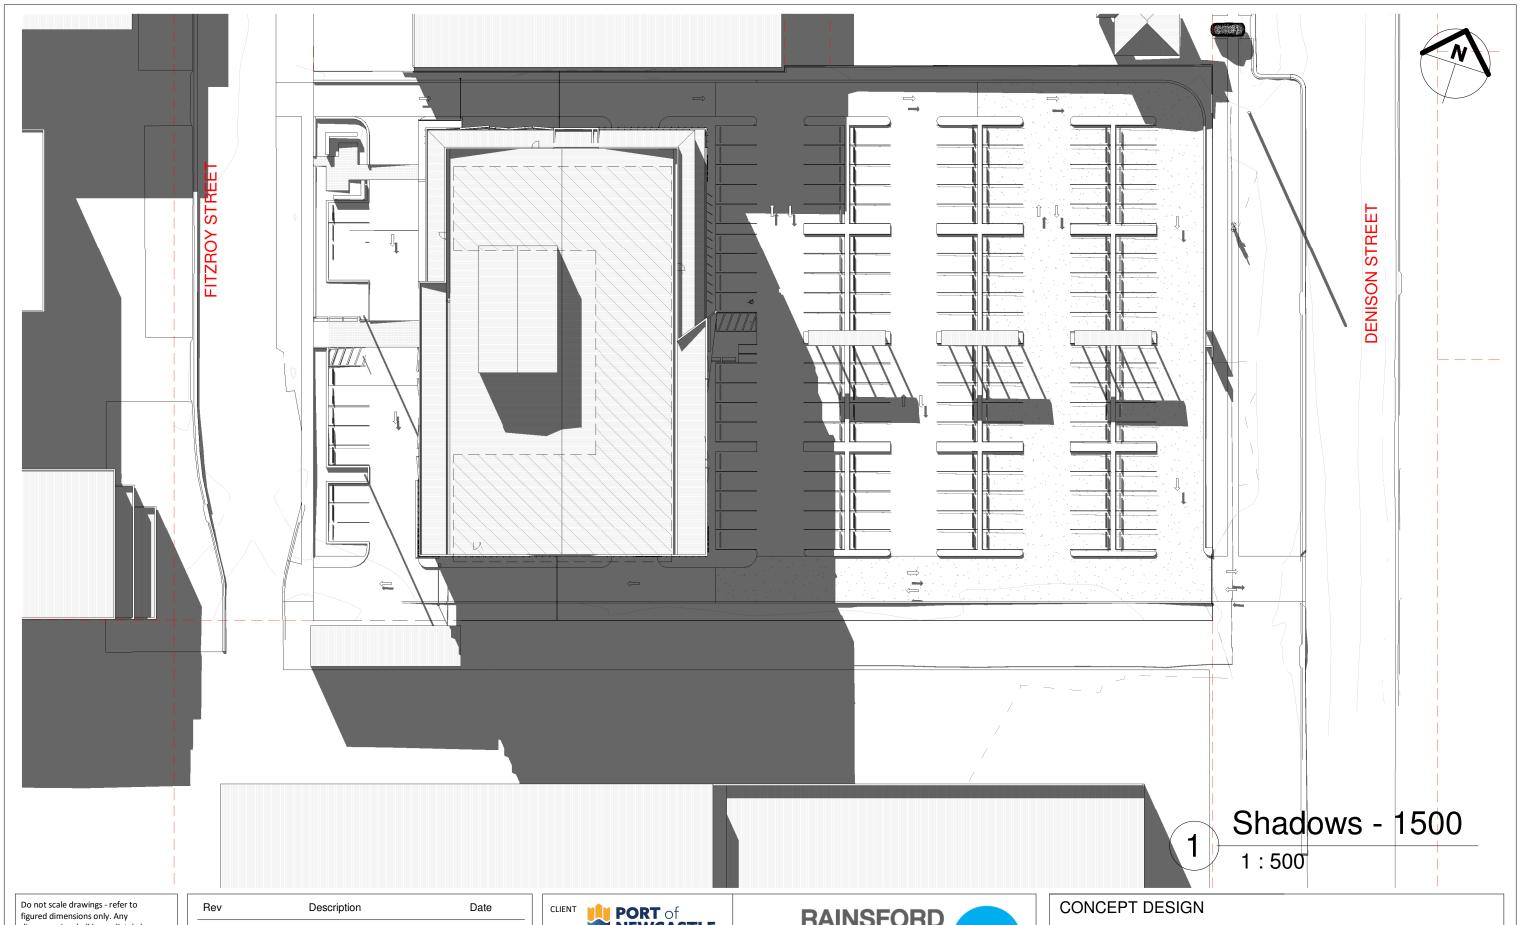
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Shadow Diagrams - 21st June 1200 STATUS DEVELOPED DESIGN @ A3

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SCALE PORT OF NEWCASTLE 1:500 PROJECT NUMBER 2020-116 REVISION N DRAWING NO. DATE MARCH 2021



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Rev	Description	Date
K	Revised for Comment	04.03.2021
L	Issued for Coordination	08.03.2021
N	Issued for Planning Approval	23.04.2021



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46 FITZROY ST, CARRINGTON - COMMERCIAL DEVELOPMENT

Shadow Diagrams - 21st June 1500 STATUS DEVELOPED DESIGN @ A3

DRAWN BY

SCALE PORT OF NEWCASTLE 1:500 PROJECT NUMBER 2020-116 REVISION N DRAWING NO. DATE MARCH 2021